

PERSPECTIVE VIEW
A-1 SCALE: NTS

## TABLE OF CONTENTS

REPUBLIC OF THE PHILIPPINES
OFFICE OF THE CITY/MUNICIPAL

OFFICE OF THE CITY/MUNICIPAL ENGINEER/BUILDING OFFICIAL

DISTRICT/CITY/MUNICIPALITY

ARCHITECTURAL

LAND USE & ZONING

A-1 PERSPECTIVE VIEW, TABLE OF CONTENTS

A-2 FLOOR PLAN, ELEVATIONS, ROOF PLAN SECTIONS, REFLECTED CEILING PLAN

A-3 SCHEDULE OF DOOR & WINDOWS, BAY SECTION, DETAIL SECTION, LOUVER BLOCK VENT., RAMP DETAIL

LINE & GRADE

ARCHITECTURAL

STRUCTURAL

S-1 FOUNDATION PLAN, ROOF FRAMING
PLAN FOOTING DETAIL, COLUMN DETAIL,
WF-1, RAMP DETAIL

STRUCTURAL

S-2 ELEVATIONS TYPICAL CONNECTION DETAIL

SANITARY

ELECTRICAL

E-1 ELECTRICAL LAYOUT PLAN, RISER DIAGRAM, LOAD SCHEDULE, GEN. NOTES

ELECTRICAL

**SANITARY** 

01 01 2006

MECHANICAL



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CHECKED BY :



RECOMMENDING APPROVAL:

OLIVER R. HERNANDEZ

CHIEF, PFSED-OPS
DepED

APPROVED BY :

	ONE STOREY ONE CLASSROOM (Modified 7x9m)	
LOCATION:		

PROJECT TITLE :


ROJECT NO: 0000009	OWNER:
ESIGNED BY: NQM	DEPARTMENT OF EDUCATI
NCODED BY: Max C.	DepED
HECKED BY: LGP	SHEET CONTENTS: FLOOR, CEILING ROOF PLANS,


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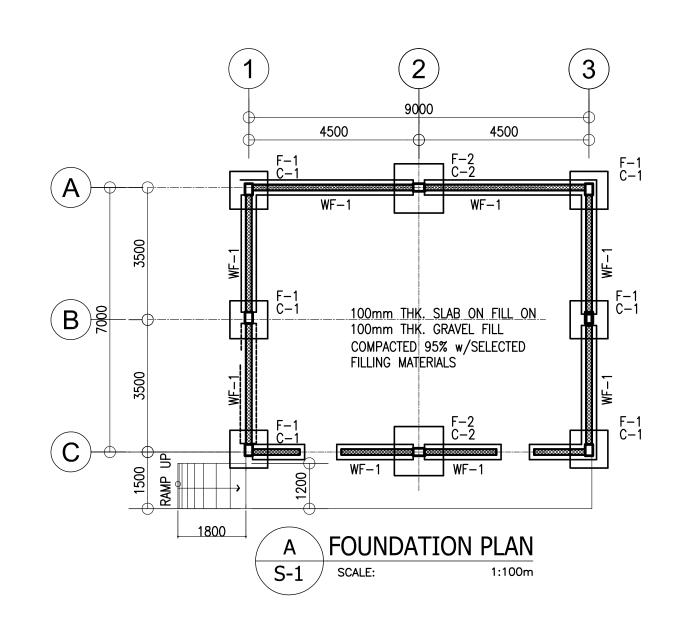
A - 1


FLOOR, CEILING ROOF PLANS, ELEVATIONS, & SECTIONS


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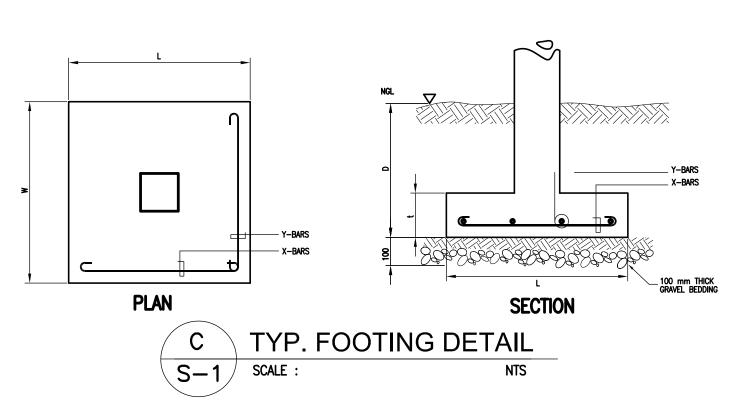





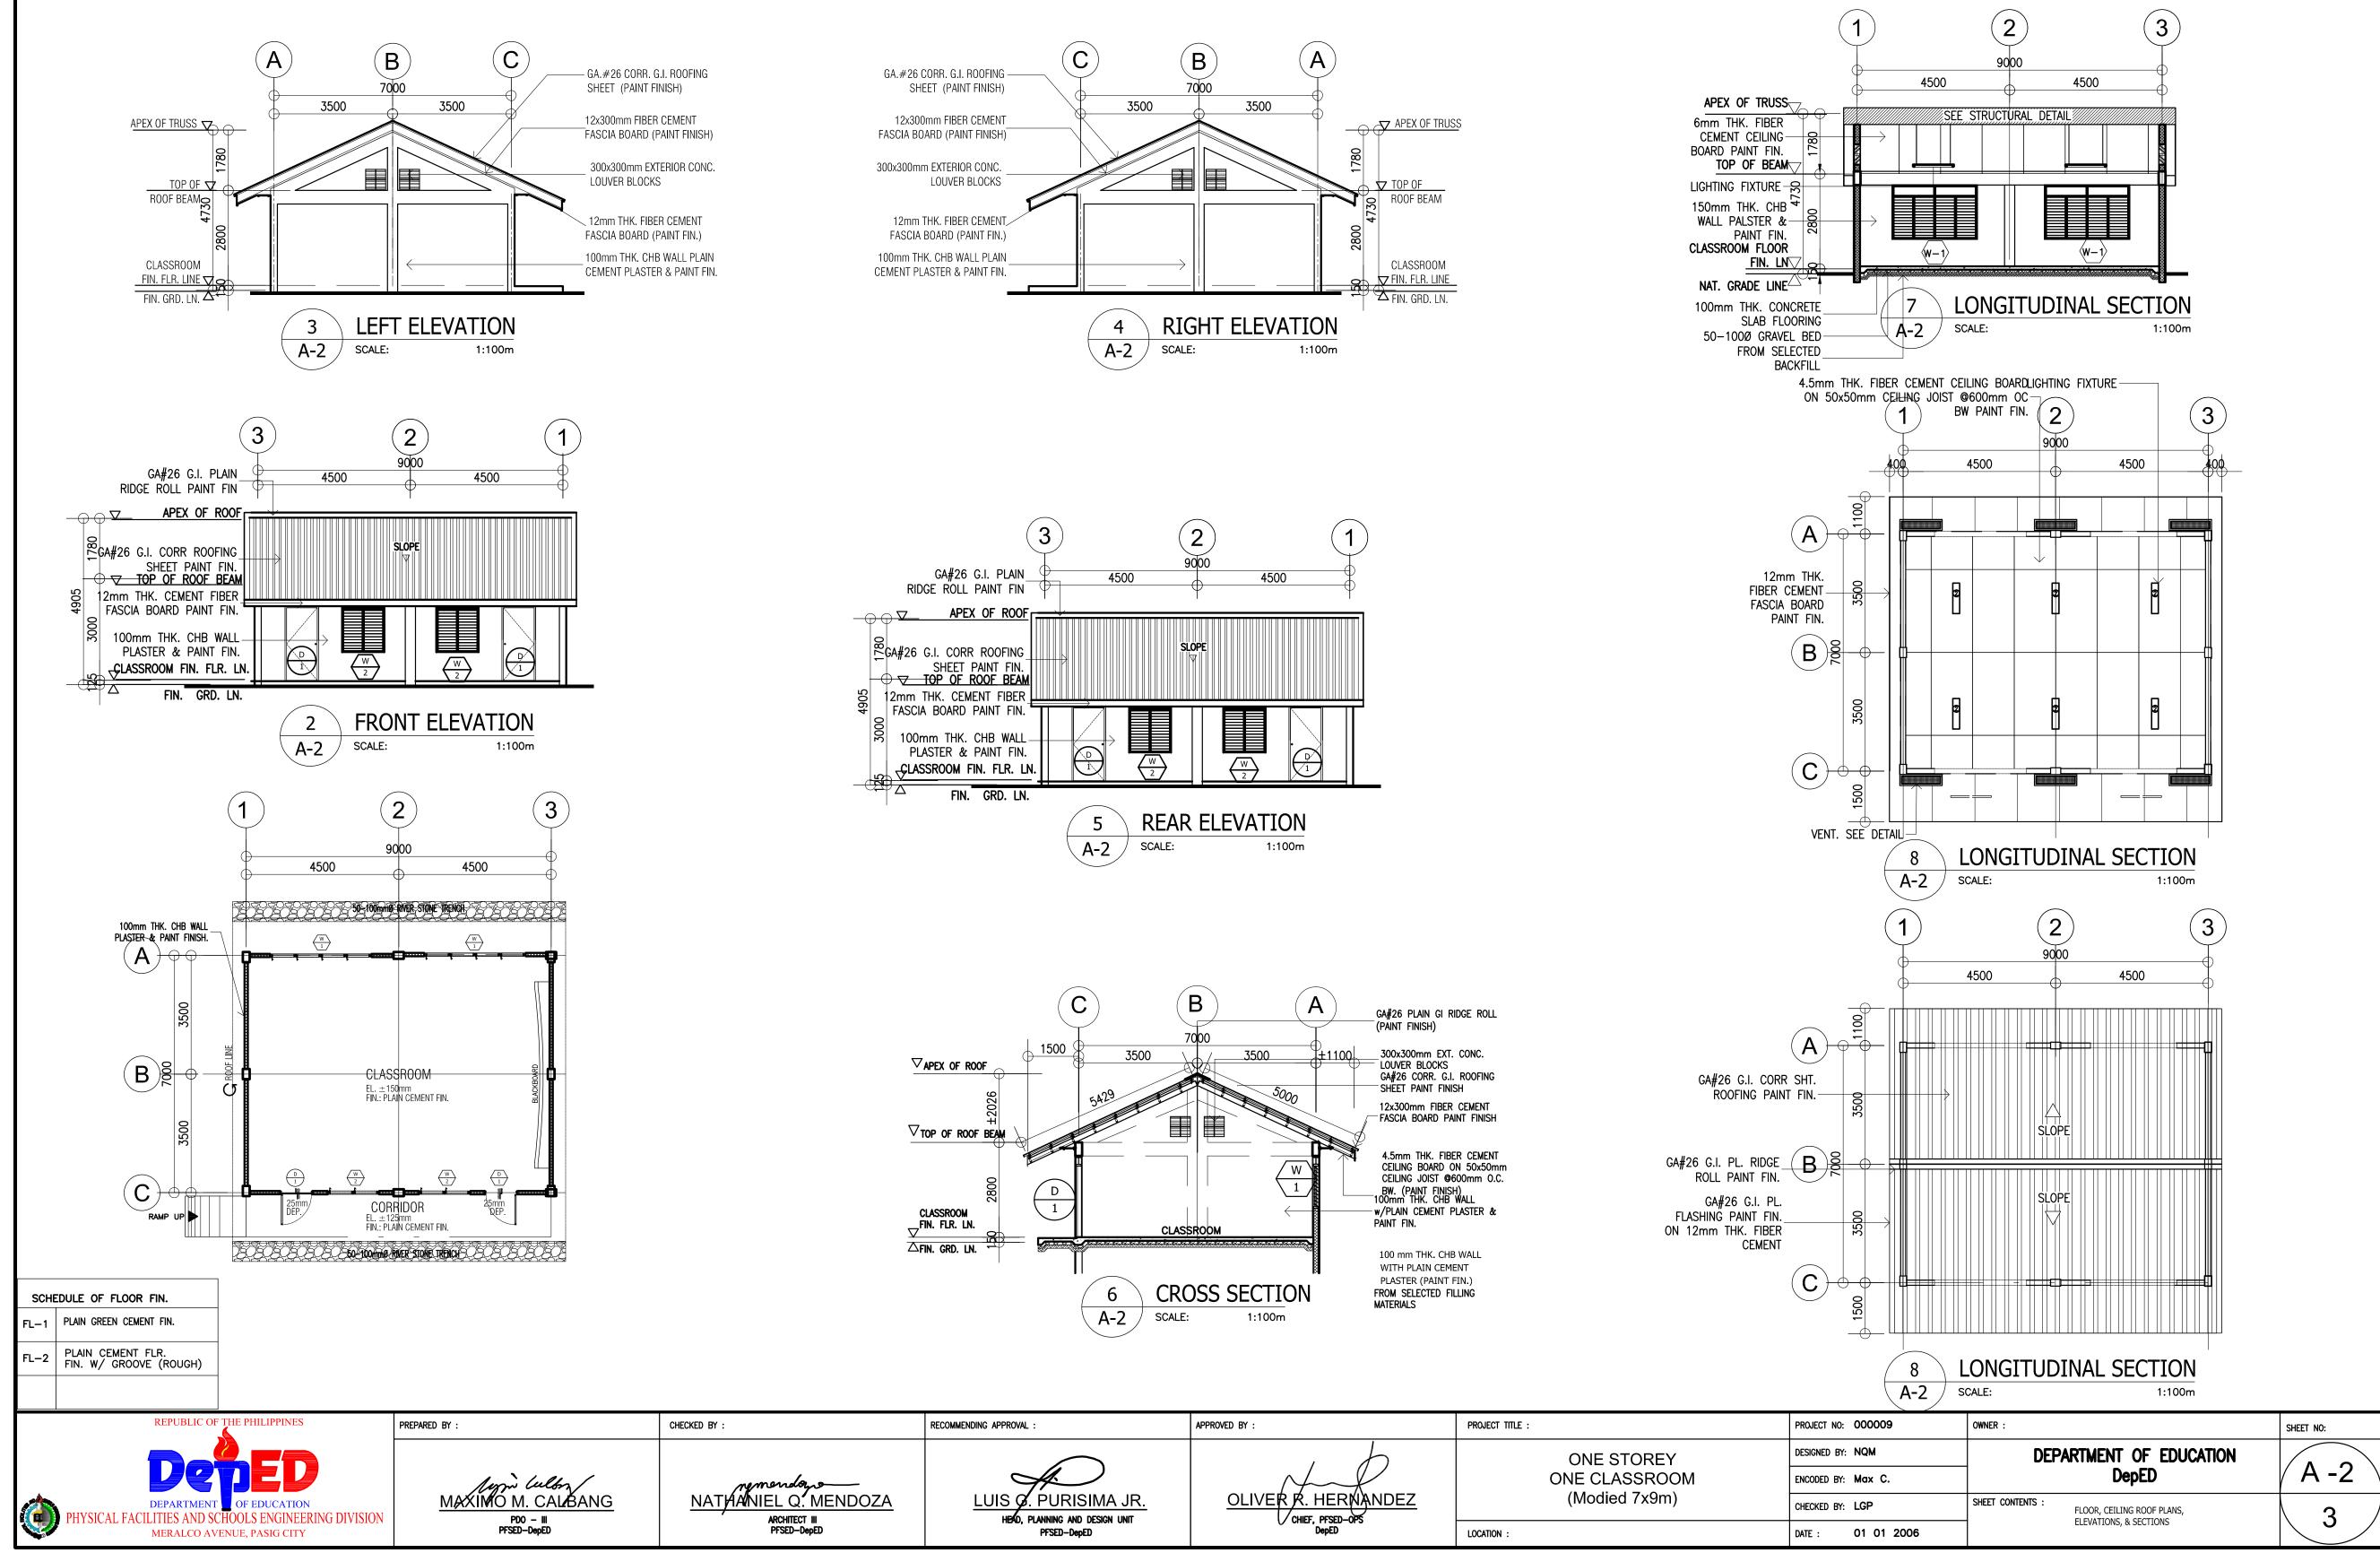


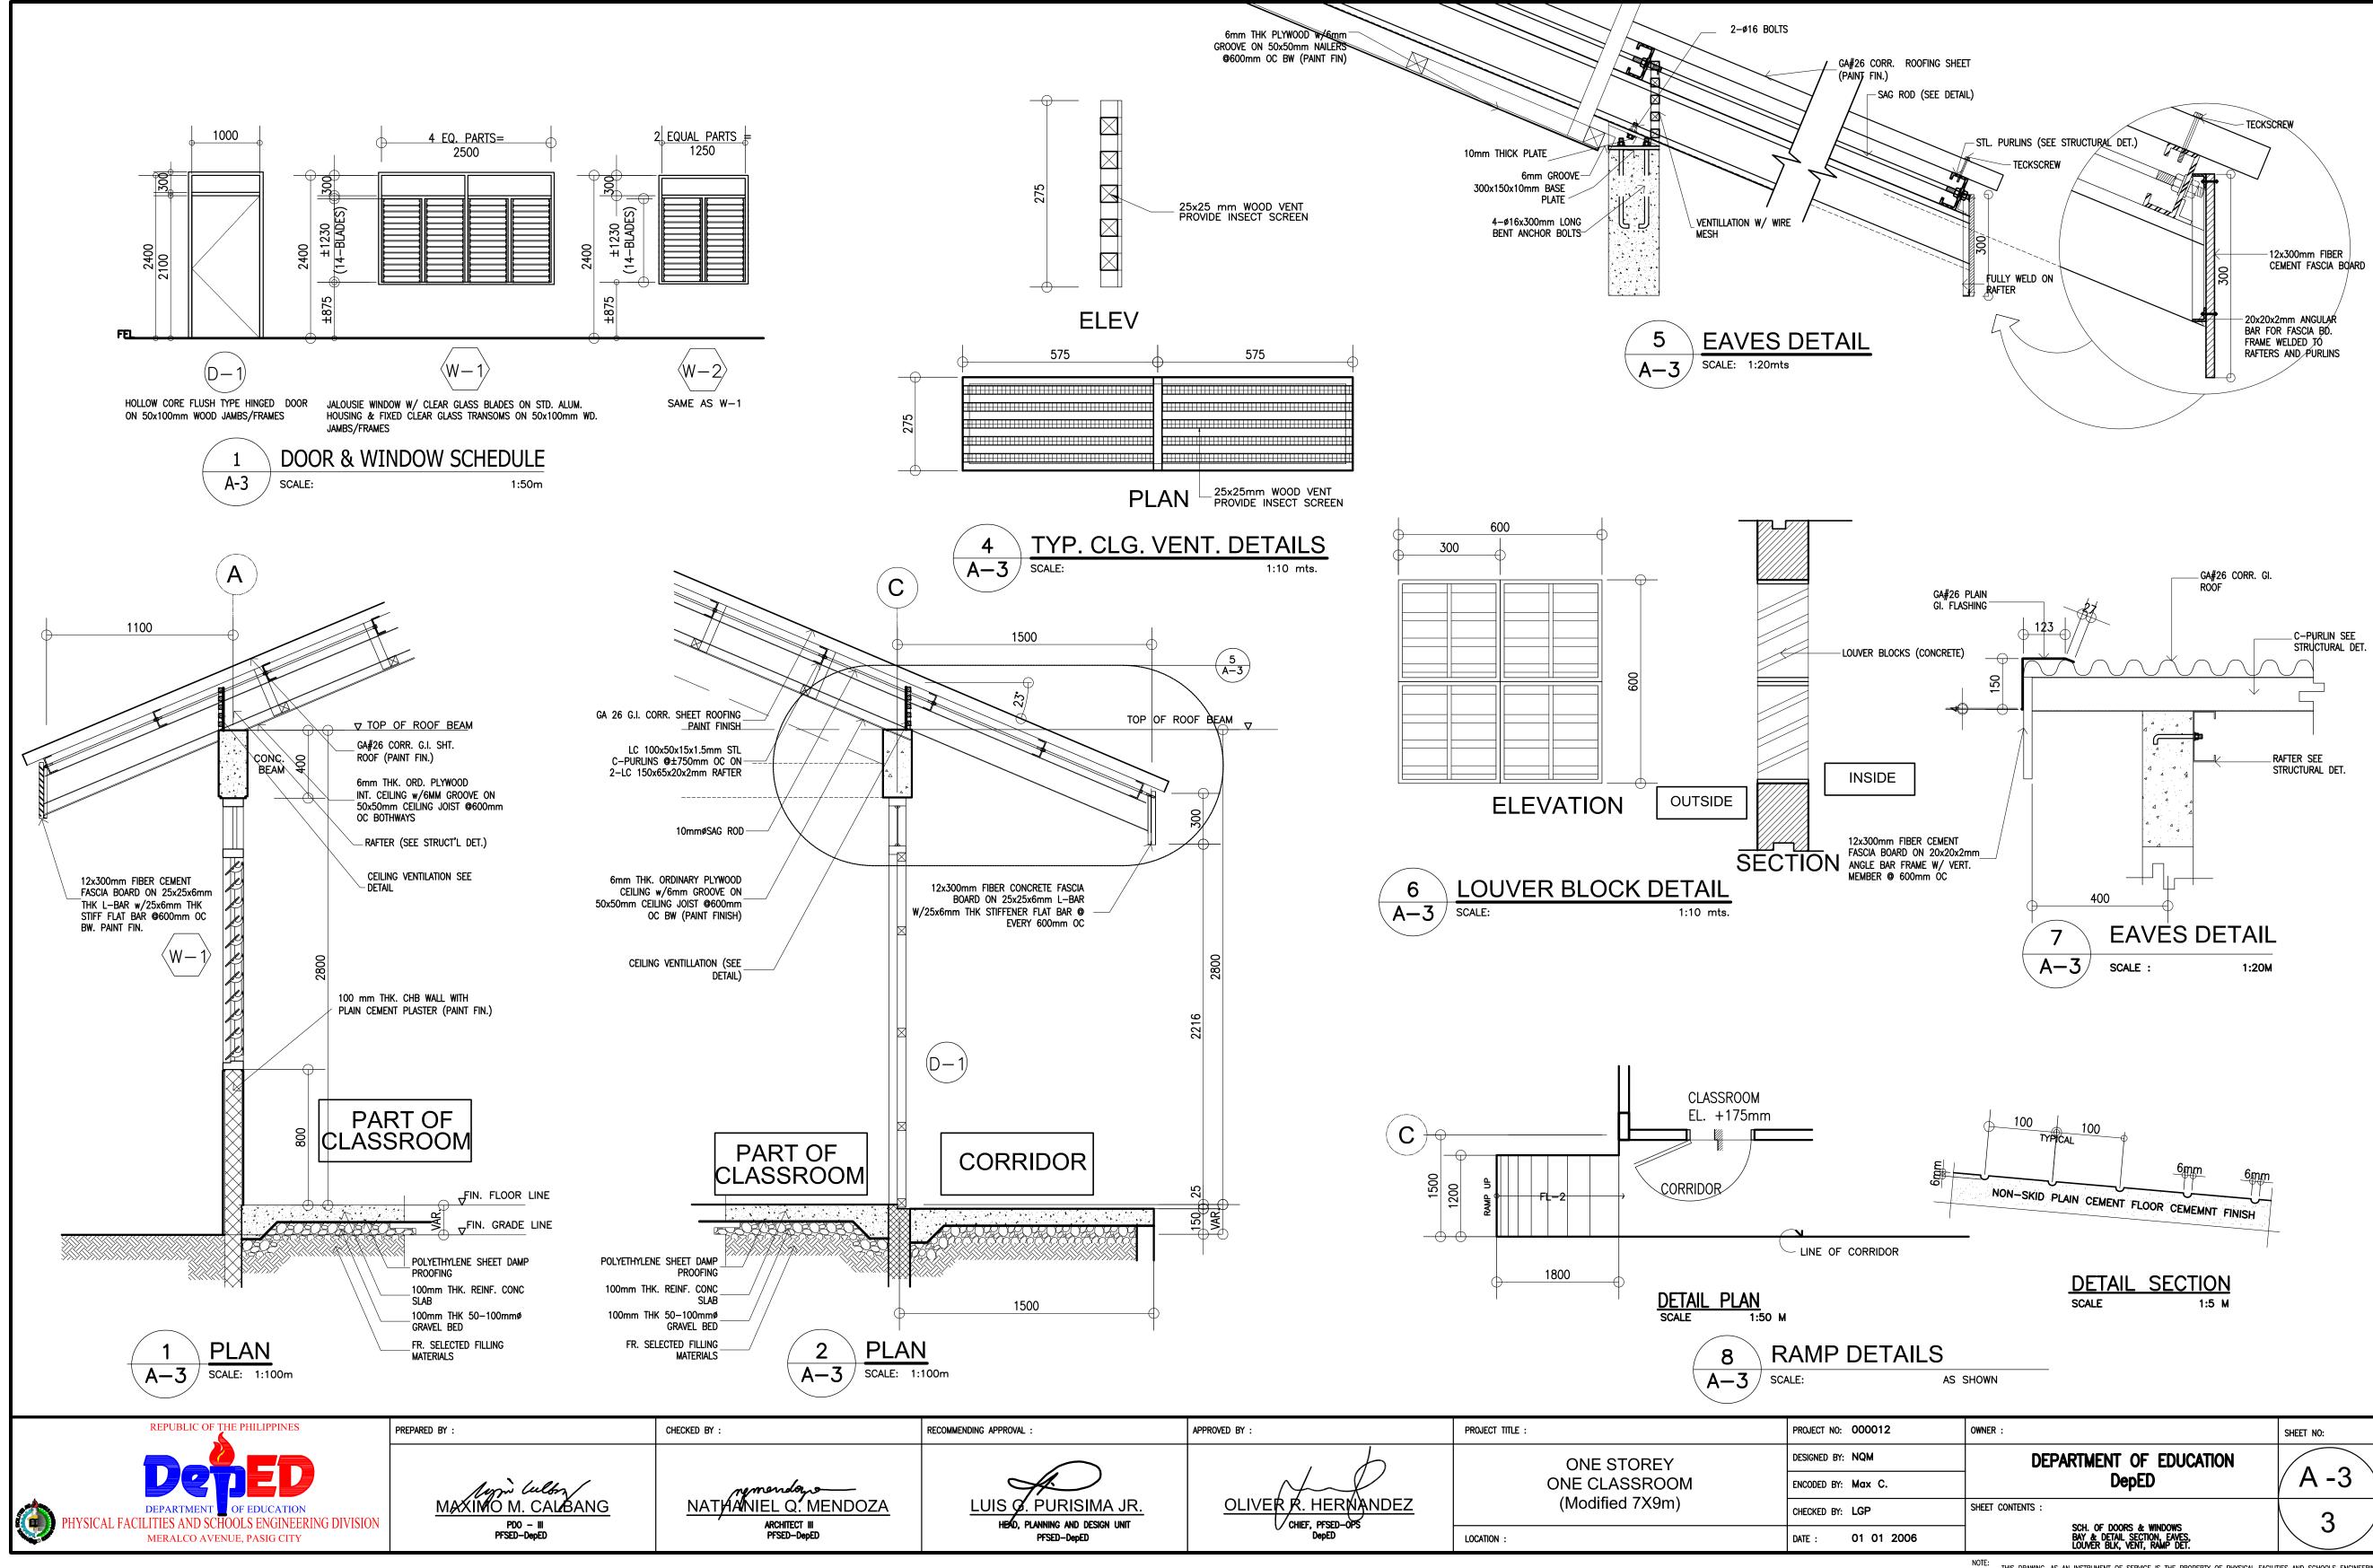

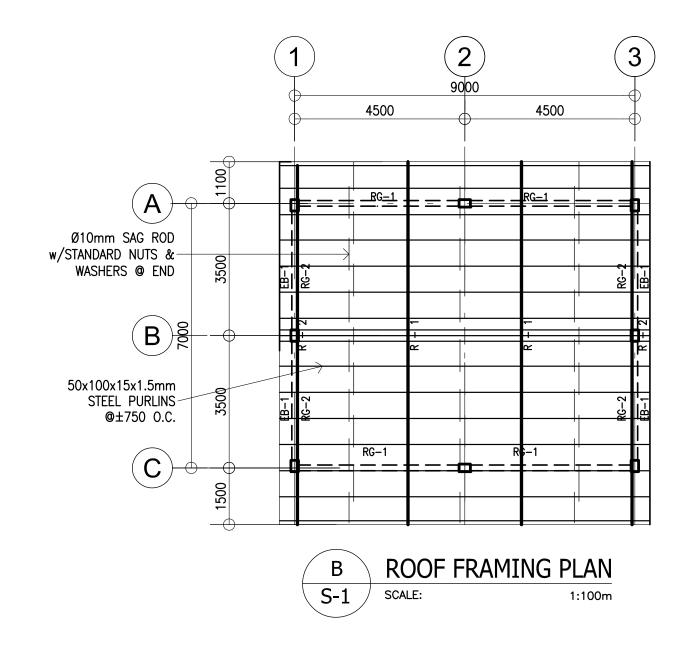

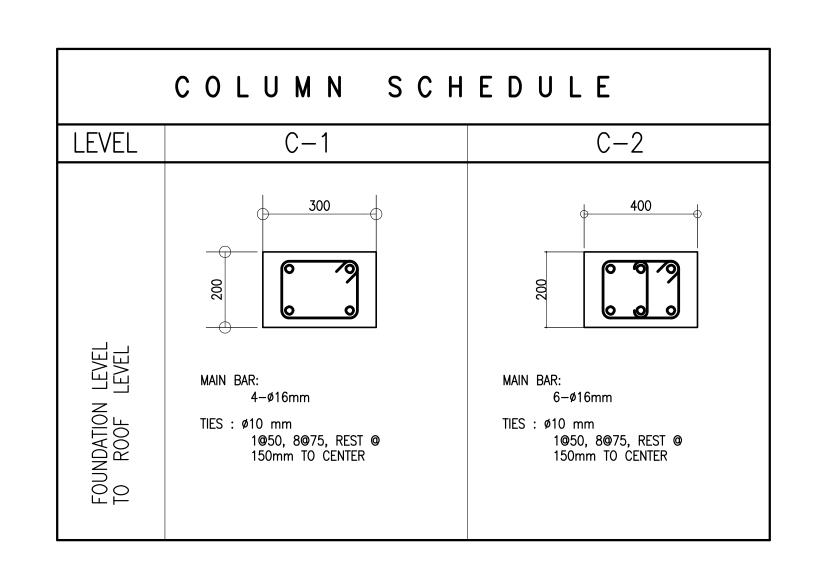

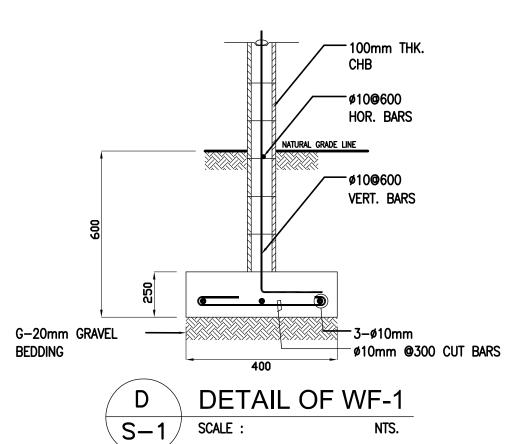

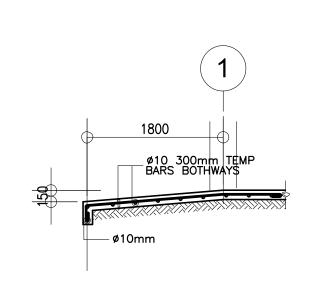

DETAIL OF RAMP S-1 SCALE

# SCHEDULE OF FOOTINGS

REMARKS
SQUARE FOOTING
SQUARE FOOTING
_

#### DESIGN CRITERIA:

A. CONCRETE

fc' = 20.685 Mpa ( 3,000 Psi ), minimum compressive strength of concrete a 28 days unless otherwise specified.

B. Rebar

fy = 275.8 Mpa ( 40,000 Psi ), minimum yield strength of reinforcing bars unless otherwise specified.

C. STRUCTURAL STEEL


DATE: 01 01 2006

Fy = 248 Mpa ( 36 Ksi ), specified minimum yield strength unless otherwise specified.

SBP = 95.706 Kpa ( 2,000 Psf ), was used in the design for all footings.


No footing shall rest on fill.




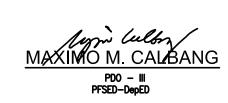



CHECKED BY:

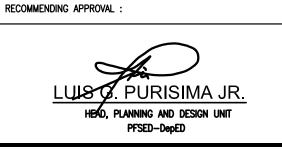

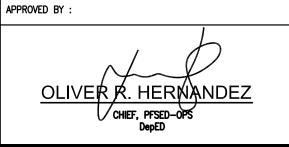


PROJECT TITLE :
ONE STOREY ONE CLASSROOM (Modified 7X9m)
LOCATION :


PROJECT NO: 000009	OWNER:
DESIGNED BY: AMA	DEPARTMENT OF EDUCAT
ENCODED BY: Max C.	DepED
CHECKED BY: LGP	SHEET CONTENTS :

S -1 FOUNDATION PLAN, ROOF FRAMING PLAN FOOTING DETAIL, COLUMN DETAIL, WF-1,

SHEET NO:

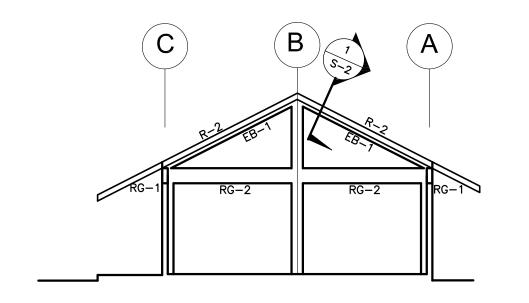




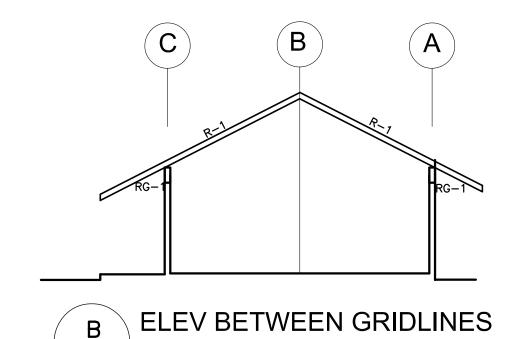



1:100 M


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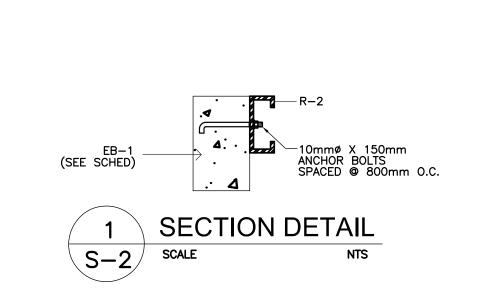


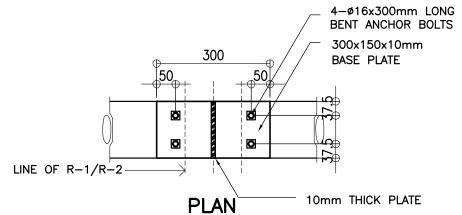
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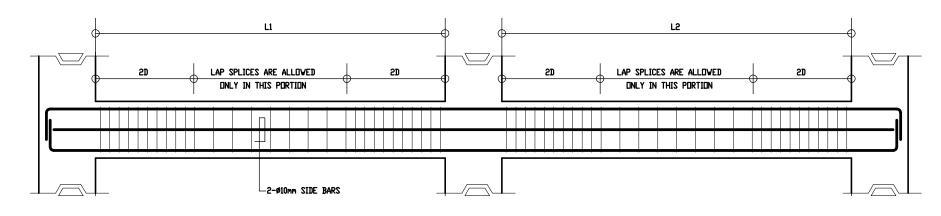




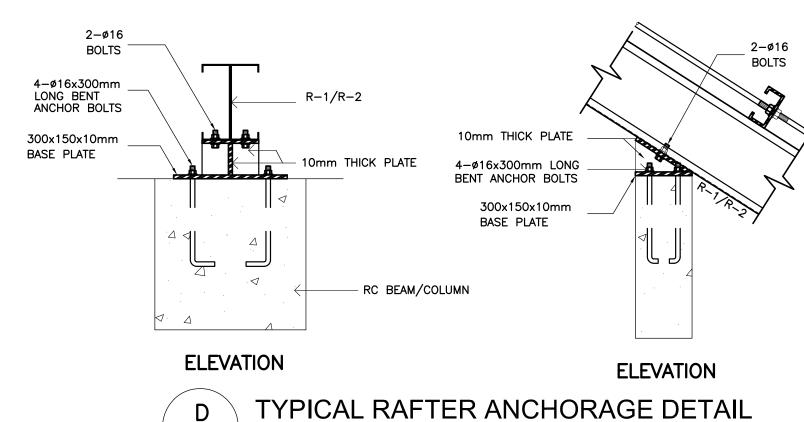

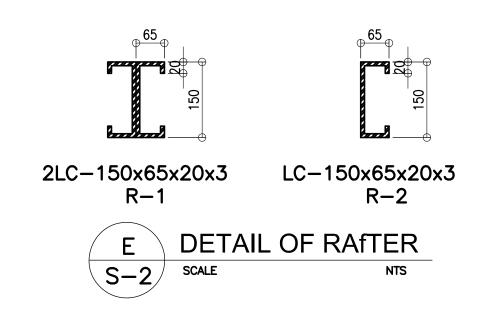


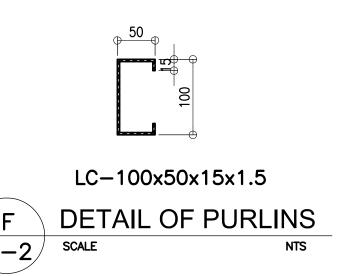

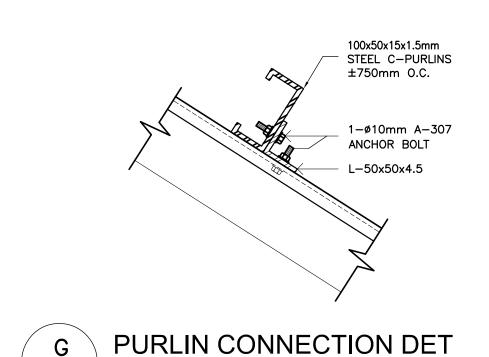


# TYPICAL BEAM ELEVATION

		В	E A	M	S	СН	E	D U	L	E	
EL OOD	DEAM	DIMEN	EAM SIONS	ST	EEL	EL REINFORCEMENTS				0.71.0.0 !! 0.0	
FLOOR   LEVEL	BEAM MARK	( in /	mm )	REBAR	LEF	ा	MID	SPAN	RI	GHT	STIRRUPS ø10mm
		b	h	(mm ø)	TOP	воттом	TOP	воттом	TOP	воттом	(UNLESS NOTED OTHERWISE)
	RG-1	150	400	ø12mm	2	2	2	2	2	2	1@50, 8@100, REST@200
LEVEL	RG-2	150	400	ø12mm	2	2	2	2	2	2	1@50, 6@100, REST@200
"											
ROOF											
	EB-1	150	250	ø10mm	2	2	2	2	2	2	1@50, REST@200

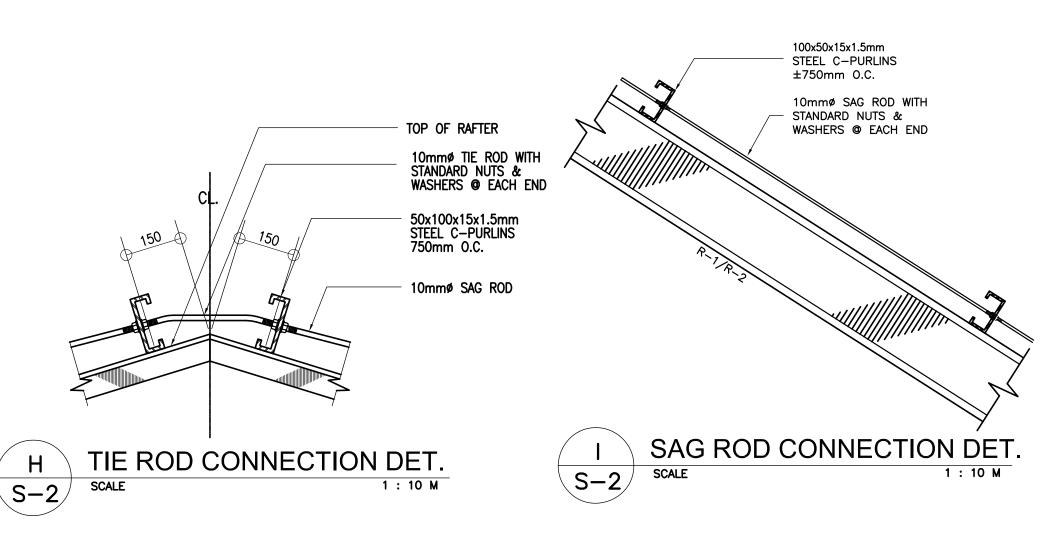






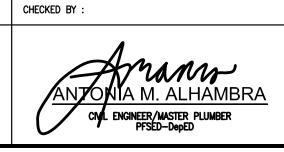



RECOMMENDING APPROVAL:

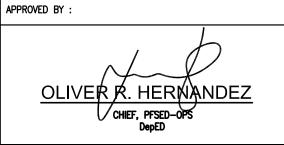

1:20 M

PROJECT TITLE :	
	ONE STOREY ONE CLASSROOM (Modified 7x9m)
LOCATION ·	

DJECT NO:	000009	OWNER:	•
SIGNED BY:	AMA	DEPARTMENT OF EDUCATION	
CODED BY:	Max C.	DepED	/
ECKED BY:	LGP	SHEET CONTENTS :	
Έ:	01 01 2006	ELEVATIONS, BEAM DETAIL & SCHED. TYPICAL CONNECTION DETAIL	`

SHEET NO:

S -2

### GENERAL NOTES

- 1. ALL ELECTRICAL WORKS SHALL COMPLY IN ACCORDANCE WITH THIS PLAN AND SPECIFICATIONS. THE APPLICABLE PROVISIONS OF THE LATEST EDITION OF THE PHILIPPINE ELECTRICAL CODE (PEC). THE RULES AND REGULATION OF THE LOCAL ENFORCING AUTHORITY AND THE REQUIREMENTS OF THE LOCAL POWER COMPANY. ALL ELECTRICAL WORKS SHALL BE UNDER THE IMMEDIATE SUPERVISION OF A DULY REGISTERED ELECTRICAL ENGINEER.
- 2. THE ELECTRICAL SERVICE POWER IS 1-PHASE, 2-WIRE, 230 V AC, 60 Hz.
- 3. WIRING METHOD SHALL BE AS FOLLOWS :
- a. FEEDERS AND RISERS
- RIGID METALLIC CONDUIT
- b. LIGHTING, POWER RECEPTACLE POLYVINYL CHLORIDE CONDUIT SCH. 40 BRANCH CKT., & AUXILIARY
- 4. ALL WIRES SHALL BE COPPER AND THERMOPLASTIC INSULATED TYPE "THW" UNLESS OTHERWISE INDICATED IN THE PLAN. THE MINIMUM SIZE OF WIRE FOR POWER AND LIGHTING CIRCUIT HOMERUN SHALL BE 3.5mm<sup>2</sup> AND INSULATED FOR 600 VOLTS. SMALLEST RACEWAY SHALL BE 15mm@ TRADE/NOMINAL SIZE.
- 5. ALL OUTLET BOXES SHALL BE GALVANIZED GAUGE NO. 16 DEEP TYPE WITH FACTORY KNOCKOUTS.
- 6. ALL MATERIALS TO BE USED SHALL BE BRAND NEW AND APPROVED TYPE FOR THE PARTICULAR LOCATION AND PURPOSE.
- 7. GROUNDING SYSTEM SHALL BE PROVIDED TO ALL LIGHTING AND POWER CIRCUIT AS PER PHILIPPINE ELECTRICAL CODE REQUIREMENT.
- 8. MOUNTING HEIGHT OF WIRING DEVICES SHALL BE AS FOLLOWS :

a. LIGHT SWITCH - 1.20 M ABOVE FINISH FLOOR

b. CONVENIENCE OUTLET 0.30 M ABOVE FINISH FLOOR.

c. SAFETY SWITCH - 1.80 M ABOVE FINISH FLOOR 1. TOTAL LOAD:

A. LIGHTING OUTLET  $5 \times 100 \text{ W} = 500 \text{ W}$ B. FAN OUTLET  $1 \times 100 \text{ W} = 100 \text{ W}$ C. CONVENIENCE OUTLET  $2 \times 180 \text{ W} = 360 \text{ W}$ TOTAL LOAD = 960 W

4. SERVICE EQUIPMENT:

2. CIRCUIT REQUIREMENT:

I LOAD


USE 30 A 2-WIRE CIRCUIT

3. SERVICE ENTRANCE CONDUCTORS:

USE 30 A, 2PST, 250V SAFETY SWITCH WITH 2-30 A, RENEWABLE FUSES


USE 2-3.5 mm<sup>2</sup> THW COPPER WIRES +1-3.5 mm<sup>2</sup>, THW(G) IN 15mmø C

960 / 230 = 4.17 A

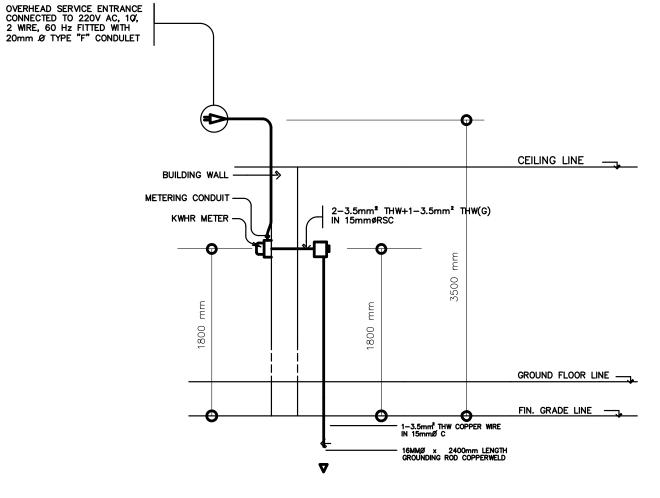


# ELECTRICAL RISER DIAGRAM

5. SCHEMATIC DIAGRAM OF SAFETY SWITCH:

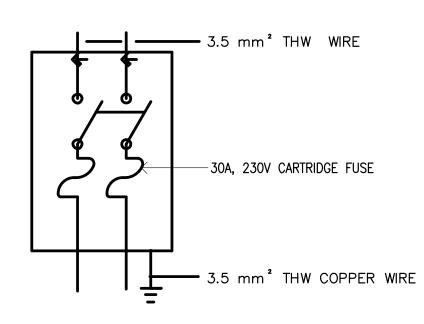



### LEGEND

SYMBOL		DESCRIPTION
<b>\$</b>	_	CEILING LIGHT OUTLET
(2)	_	2 x 40 WATTS FLUORESCENT LAMP
F	_	CEILING FAN OUTLET
S/Sa	_	ONE GANG DEVICE SWITCH
Sab	_	TWO GANG DEVICE SWITCH
Scde	_	THREE GANG DEVICE SWITCH
(1)	_	1 x 40 WATTS FLUORESCENT LAMP
Sf	_	FAN CONTROL SWITCH
	_	RACEWAY CONDUIT CONCEALED IN CEILING
	_	RACEWAY CONDUIT CONCEALED UNDER FLOOR
Ò	_	SAFETY SWITCH
<b>=</b>	_	DUPLEX CONVENIENCE OUTLET, GROUNDING TYPE 10 AMPS, 250 VOLT WITH MODERN PLATE COVER
•	_	ELECTRIC SERVICE METER
<b>◆</b>	_	SERVICE ENTRANCE

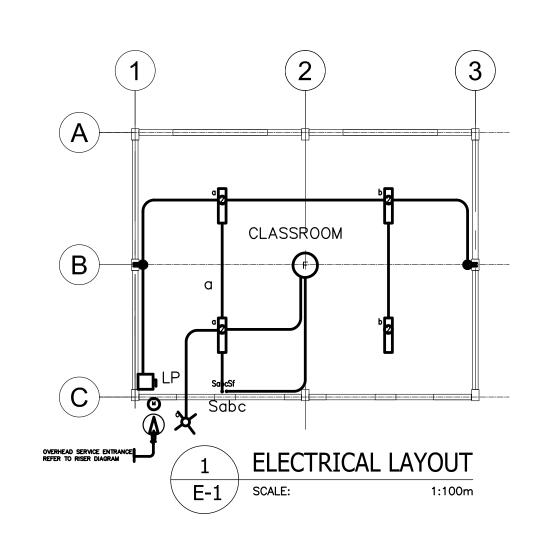



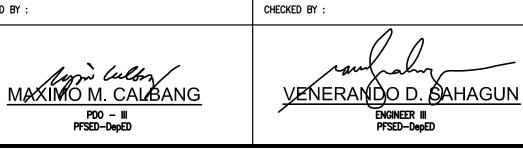

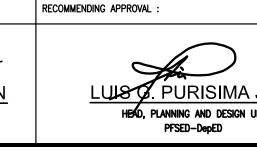

APPROVED BY :
OLIVER R. HERNANDEZ  CHIEF, PFSED-OPS DepED

	ONE STOREY ONE CLASSROOM (Modified 7x9m)	
LOCATION ·		

PROJECT TITLE :

OJECT NO:	000009	OWNER:		SHEET NO:
SIGNED BY:	VDS	DEPARTMENT OF	EDUCATION	1
CODED BY:	Max C.	DepED		/ <b>L</b> -
IECKED BY:	LGP	SHEET CONTENTS :	CALCULATIONS	1
TE:	01 01 2006	GENERAL NOTES ELECTRICAL LAYOUT	LEGEND RISER DIAGRAM	